

# UNITED STATES COAST GUARD

# GYM POOL VENTILATION UNIT REPLACEMENT

# TRACEN

# CAPE MAY, NEW JERSEY

## GENERAL NOTES

1. THE INFORMATION PROVIDED ON THE CONTRACT DRAWINGS IS BELIEVED TO BE CORRECT. HOWEVER, THE CONTRACTOR SHALL FIELD VERIFY ALL INFORMATION.

2. CONTRACTOR SHALL PROVIDE QUOTES TO PERFORM WORK LISTED UNDER THIS SOLICITATION.

3. TWO PRE-BID SITE VISITS WILL BE SCHEDULED BY THE OWNER. THE FIRST PRE-BID SITE VISIT WILL BE HELD APPROXIMATELY TWO WEEKS AFTER THE RELEASE OF THE SOLICITATION. THE SECOND PRE-BID SITE VISIT WILL BE HELD APPROXIMATELY THREE WEEKS AFTER THE RELEASE OF SOLICITATION. IT IS THE RESPONSIBILITY OF THE CONTRACTOR TO CONTACT THE PROJECT ENGINEER, LT JUSTIN DAVIS, FACILITIES ENGINEERING, DESIGN SECTION, AT 609-898-6406 TO OBTAIN THE SPECIFIC DATES, AS NO OTHER SITE VISITS WILL BE SCHEDULED.

4. THE CONTRACTOR CAN EXPECT THE BUILDING TO BE IN USE AT ALL TIMES.

5. THE INTENT IS TO REPLACE EXISTING POOL PAK UNIT WITH THE EQUIVALENT UNIT FROM POOL PAK. ALL ELECTRICAL AND DUCTWORK CONNECTIONS WILL BE IN THE SAME LOCATIONS. ALL STRUCTURAL SUPPORTS AND ROOF CONNECTIONS SHALL REMAIN UNCHANGED.
6. THE TRAINING CENTER'S SHOP PERSONNEL WILL BE ABLE TO ASSIST IN THE LOCATION AND IDENTIFICATION OF THE ROOF TOP UNITS ELECTRICAL AND CONTROLS INTERFACE.


7. THE GOVERNMENT WILL RETAIN ALL RECYCLABLE MATERIAL IF THEY CHOOSE. INCLUDING COILS. EVACUATION AND RECYCLING OF ALL REFRIGERANT IS RESPONSIBILITY OF THE CONTRACTOR

## SHEET INDEX


TITLE SHEET	1 OF 6
SITE MAP	2 OF 6
EXISTING ROOF PLAN-CORE AREA	3 OF 6
HVAC DEMOLITION & INSTALLATION PLAN	4 OF 6
HVAC DETAILS AND SCHEDULE	5 OF 6
ELECTRICAL PLANS	6 OF 6

MECHANICAL SYMBOLS			
SYMBOL	DESCRIPTION	SYMBOL	DESCRIPTION
	GATE VALVE		HOT WATER SUPPLY (HEATING)
	GLOBE VALVE		HOT WATER RETURN (HEATING)
	CHECK VALVE		EQUIPMENT DRAIN
	BUTTERFLY VALVE		REFRIGERANT SUCTION
	ECCENTRIC PLUG VALVE		REFRIGERANT LIQUID
	BALL VALVE		REFRIGERANT HOT GAS DISCHARGE
	STRAINER		PROPYLENE GLYCOL SUPPLY
	UNION		PROPYLENE GLYCOL RETURN
	FLANGE		DUCTWORK RECTANGULAR DUCT(FIRST NUMBER IS SIDE SHOWN IN INCHES)
	CAP		SUPPLY AIR DUCT
	BLIND FLANGE		RETURN OR EXHAUST DUCT
	SHUTOFF VALVE (GATE, PLUG, BUTTERFLY OR BALL)		OUTSIDE AIR DUCT
	PRESSURE REGULATING VALVE		FLEXIBLE CONNECTION
	SOLENOID VALVE		VOLUME DAMPER
	CONTROL VALVE (2-WAY)		MOTORIZED DAMPER OR CONTROL DAMPER - CD
	CONTROL VALVE (3-WAY)		FLEXIBLE DUCT
	THERMOMETER		FIRE DAMPER-FD
	PRESSURE GAGE		SMOKE DAMPER-SD
	SAFETY RELIEF VALVE		COMBINATION FIRE & SMOKE DAMPER-FD/SD
	COCK (GAGE,AIRVENT,DRAIN)		DUCT PRESSURE CLASS DESIGNATION
	FLOW MEASURING ELEMENT		RETURN GRILLE WITH ACOUSTIC BOOT
	TEST PLUG		TRANSFER DUCT ABOVE CEILING
	SIGHT GLASS (FLOW TYPE)		BACKDRAFT DAMPER-BD
	AIR ELIMINATOR		
	TEMP. & PRESS. RELIEF VALVE		
	RL RELIEF VALVE		
	PIPE ELBOW UP		
	PIPE ELBOW DOWN		
	PIPE TEE UP		
	PIPE TEE DN		
	FLOOR -FD TRENCH -TD		
	AREA-MD		
	ROOF DRAIN		
	CONNECT TO EXISTING		


UNITED STATES COAST GUARD  
TRAINING FACILITY CAPE MAY

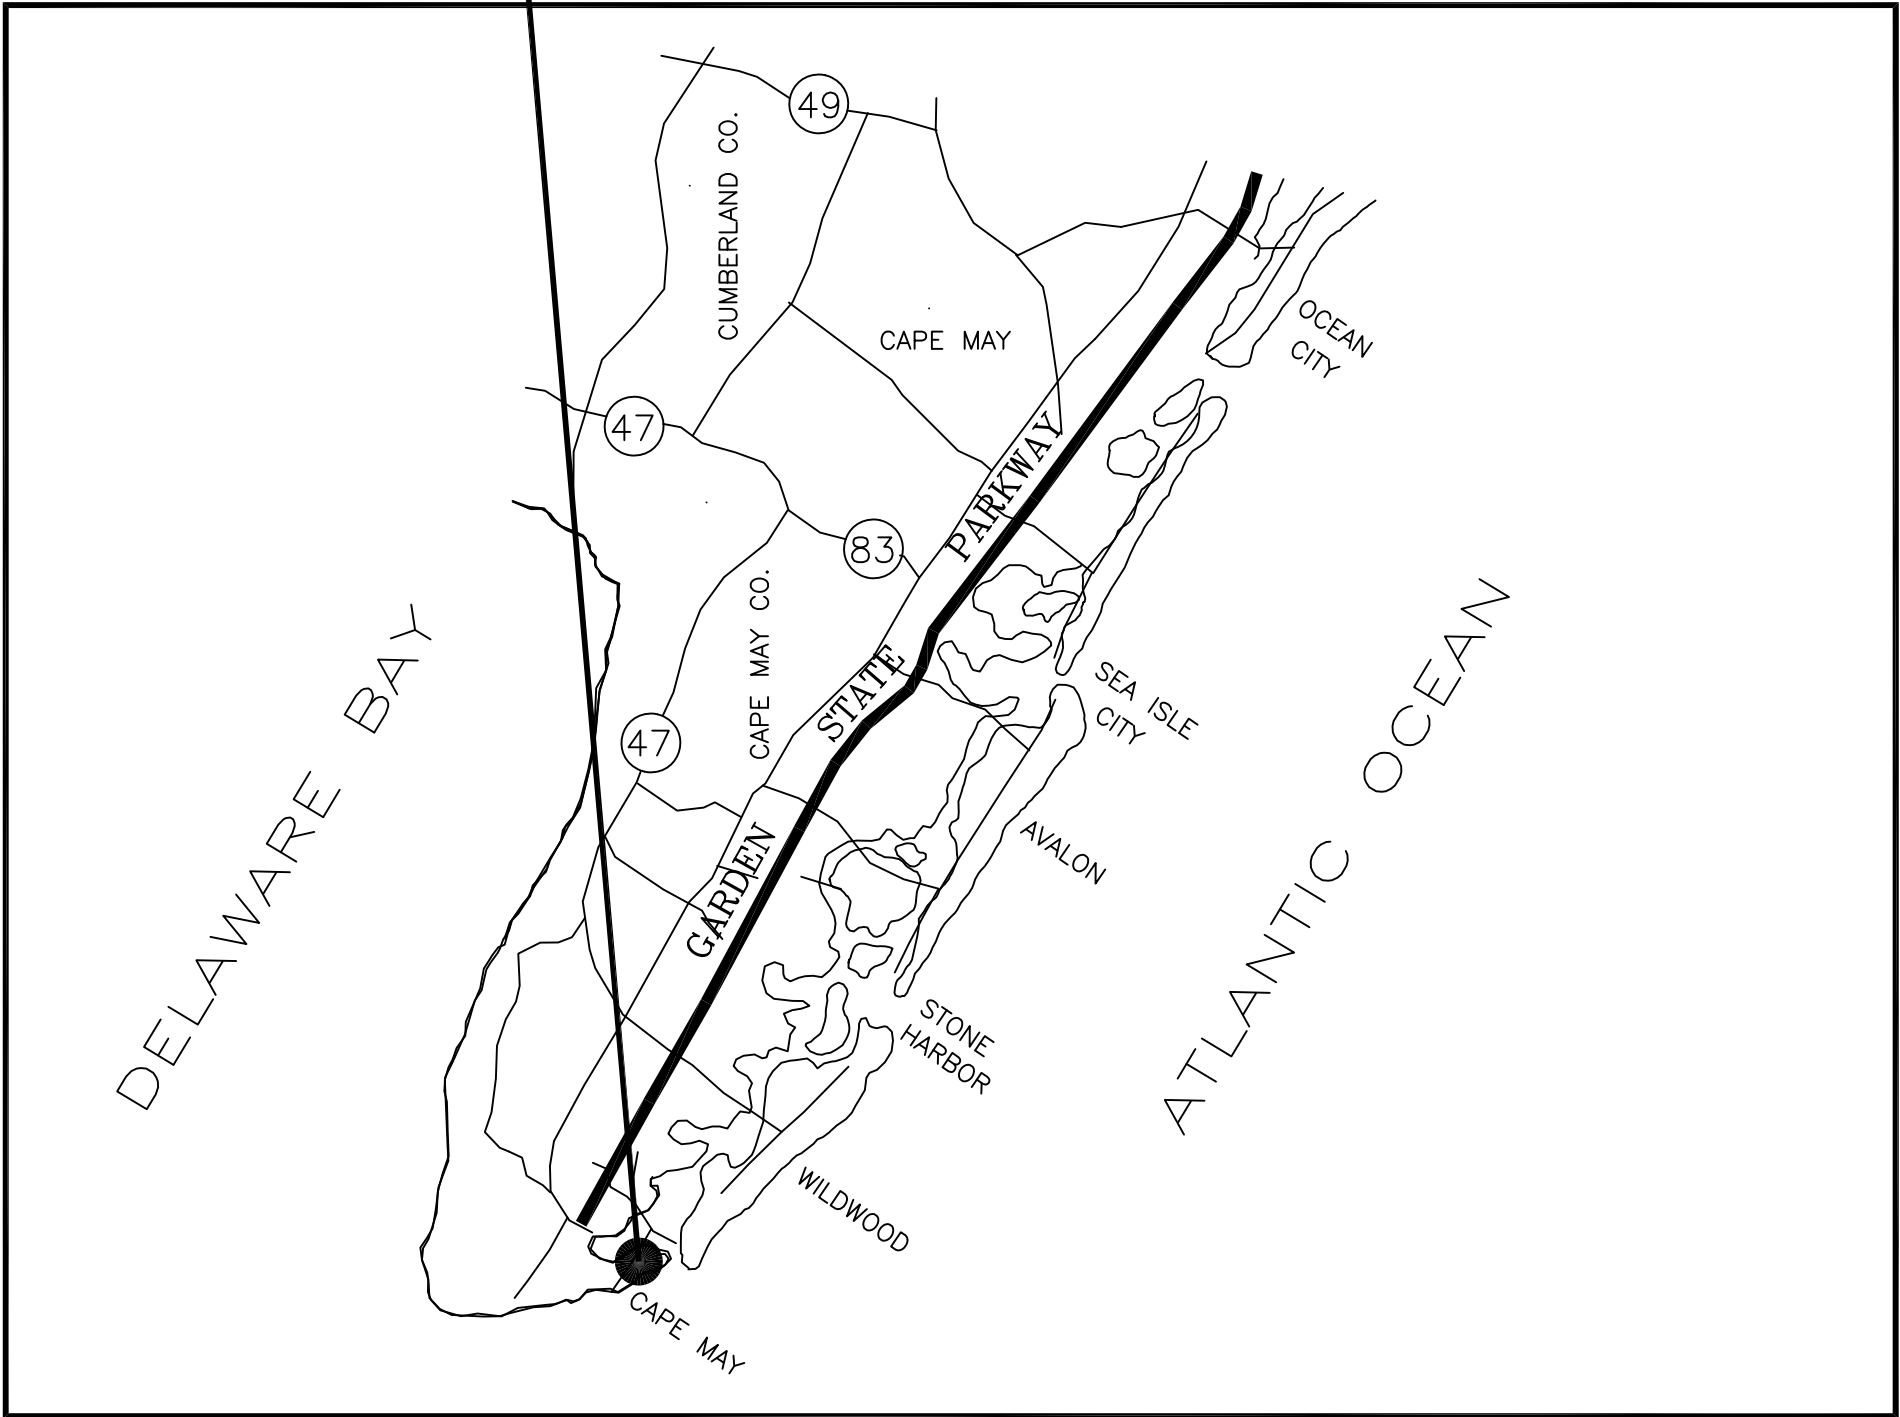

LOCATION MAP  
SCALE: N.T.S.

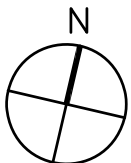


GYMNASIUM  
BLDG 269

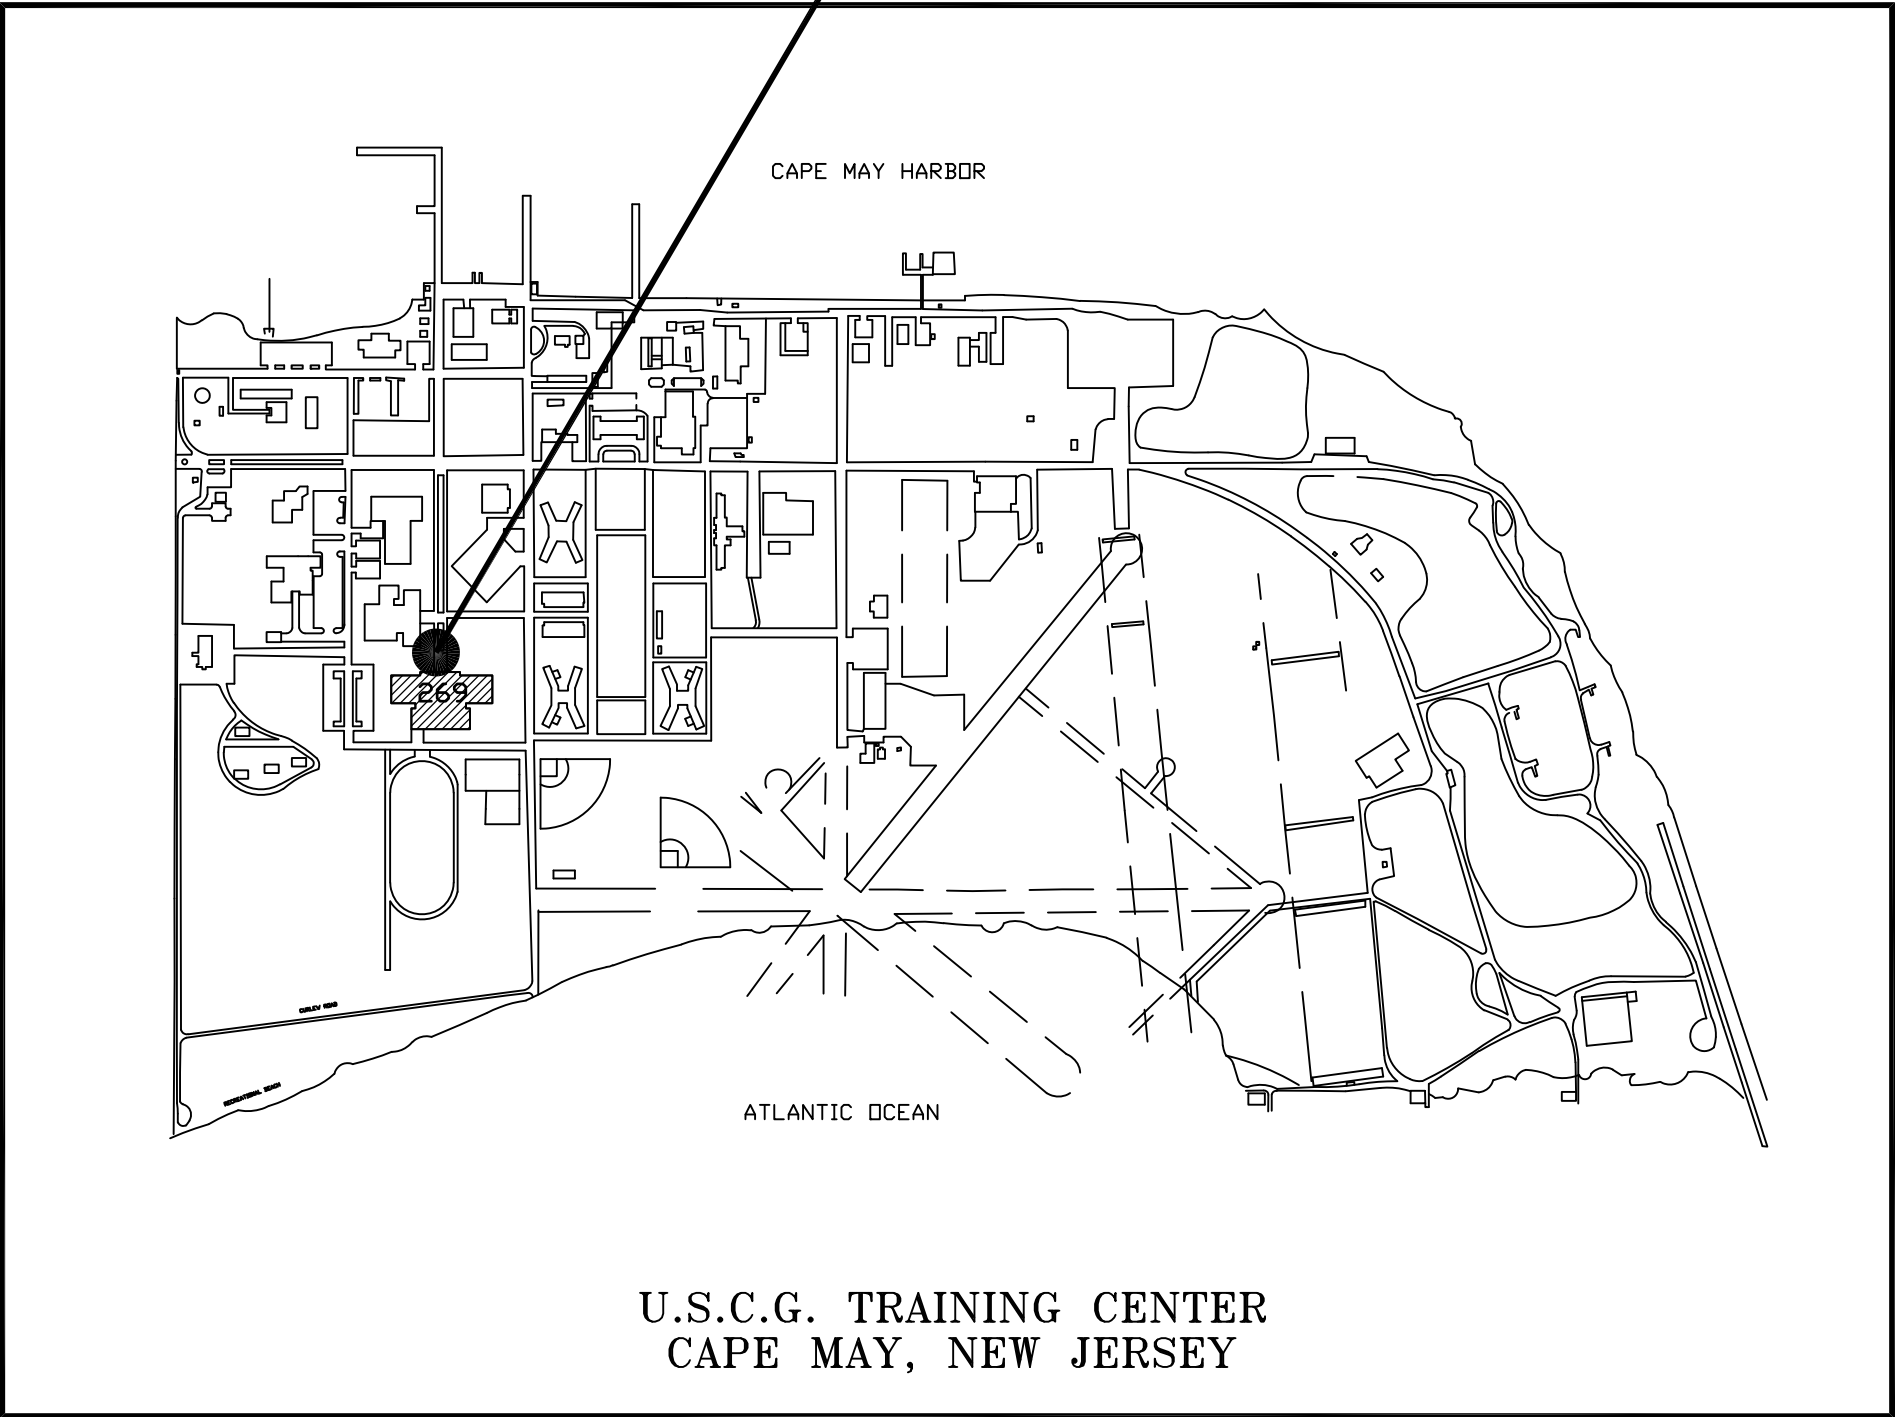


U.S.C.G. TRAINING CENTER  
CAPE MAY, NEW JERSEY

VICINITY MAP  
SCALE: N.T.S.

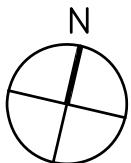

CONSULTANTS

U. S. COAST GUARD  
TRAINING CENTER  
CAPE MAY

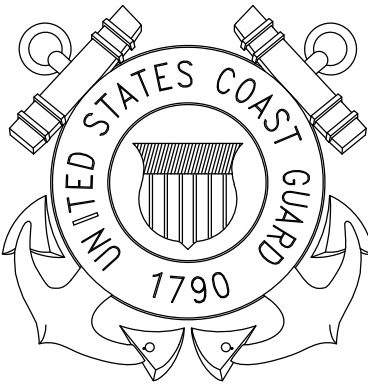

USCG TRACEN CAPE MAY  
1 MUNRO AVE.  
CAPE MAY, NJ 08204-5092

ISSUE

MARK	DATE	DESCRIPTION
------	------	-------------

A/E PROJECT NO: CMS- 1576  
CAD FILE NAME: T-7087-GD TITLE SHEET.dwg  
DESIGNED BY: LT JUSTIN DAVIS  
DRAWN BY: LT JUSTIN DAVIS  
EDITED BY:  
CHECKED BY:

SCALE: 1/8" = 1'-0" PLOT SCALE: 1 : 1

SHEET TITLE

GYM POOL VENTILATION UNIT REPLACEMENT  
TRACEN  
CAPE MAY NEW JERSEY  
GYM, RPFN 269  
GENERAL  
TITLE SHEET

PROJECT ENG.

BRANCH CHIEF

APPROVING OFFICER

6/28/19  
DATE

PROJECT NUMBER

DRAWING NUMBER


12672868

T-7087-CD

DISCIPLINE/SHT NO

G1

SHEET 1 OF 6

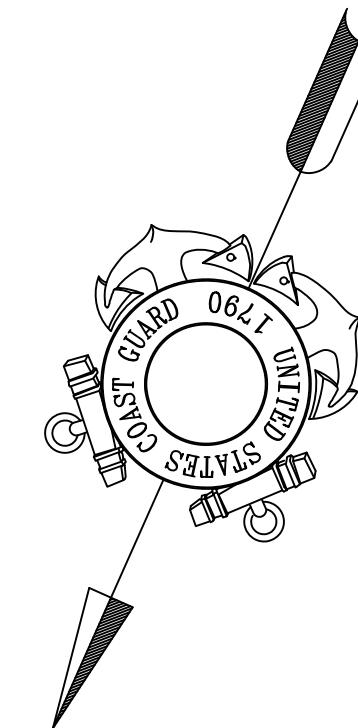

U. S. COAST GUARD  
TRAINING CENTER  
CAPE MAY



USCG, TRACEN CAPE MAY  
1 MUNRO AVE.  
CAPE MAY, NJ 08204-5092

ISSUE		
MARK	DATE	DESCRIPTION

A/E PROJECT NO:CMS- 1576
CAD FILE NAME: T-7088-CD SITE MAP.dwg
DESIGNED BY: LT JUSTIN DAVIS
DRAWN BY: LT JUSTIN DAVIS
EDITED BY:
CHECKED BY:


SCALE: AS SHOWN PLOT SCALE:

SHEET TITLE
-------------


GYM POOL VENTILATION UNIT REPLACEMENT  
TRACEN  
CAPE MAY NEW JERSEY  
GYM, RPFN 269  
CIVIL  
SITE MAP


PROJECT ENG.		BRANCH CHIEF	
		6/28/19	
_____ APPROVING OFFICER		_____ DATE	
PROJECT NUMBER		DRAWING NUMBER	
12672868		T-7088-CD	
DISCIPLINE/SHT NO			
C1		SHEET 2 OF 6	

EXISTING GYM ROOF PLAN  
SCALE: 1/16" = 1'-0"


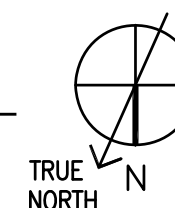


GRAPHICAL SCALE:  $1/16" = 1'$



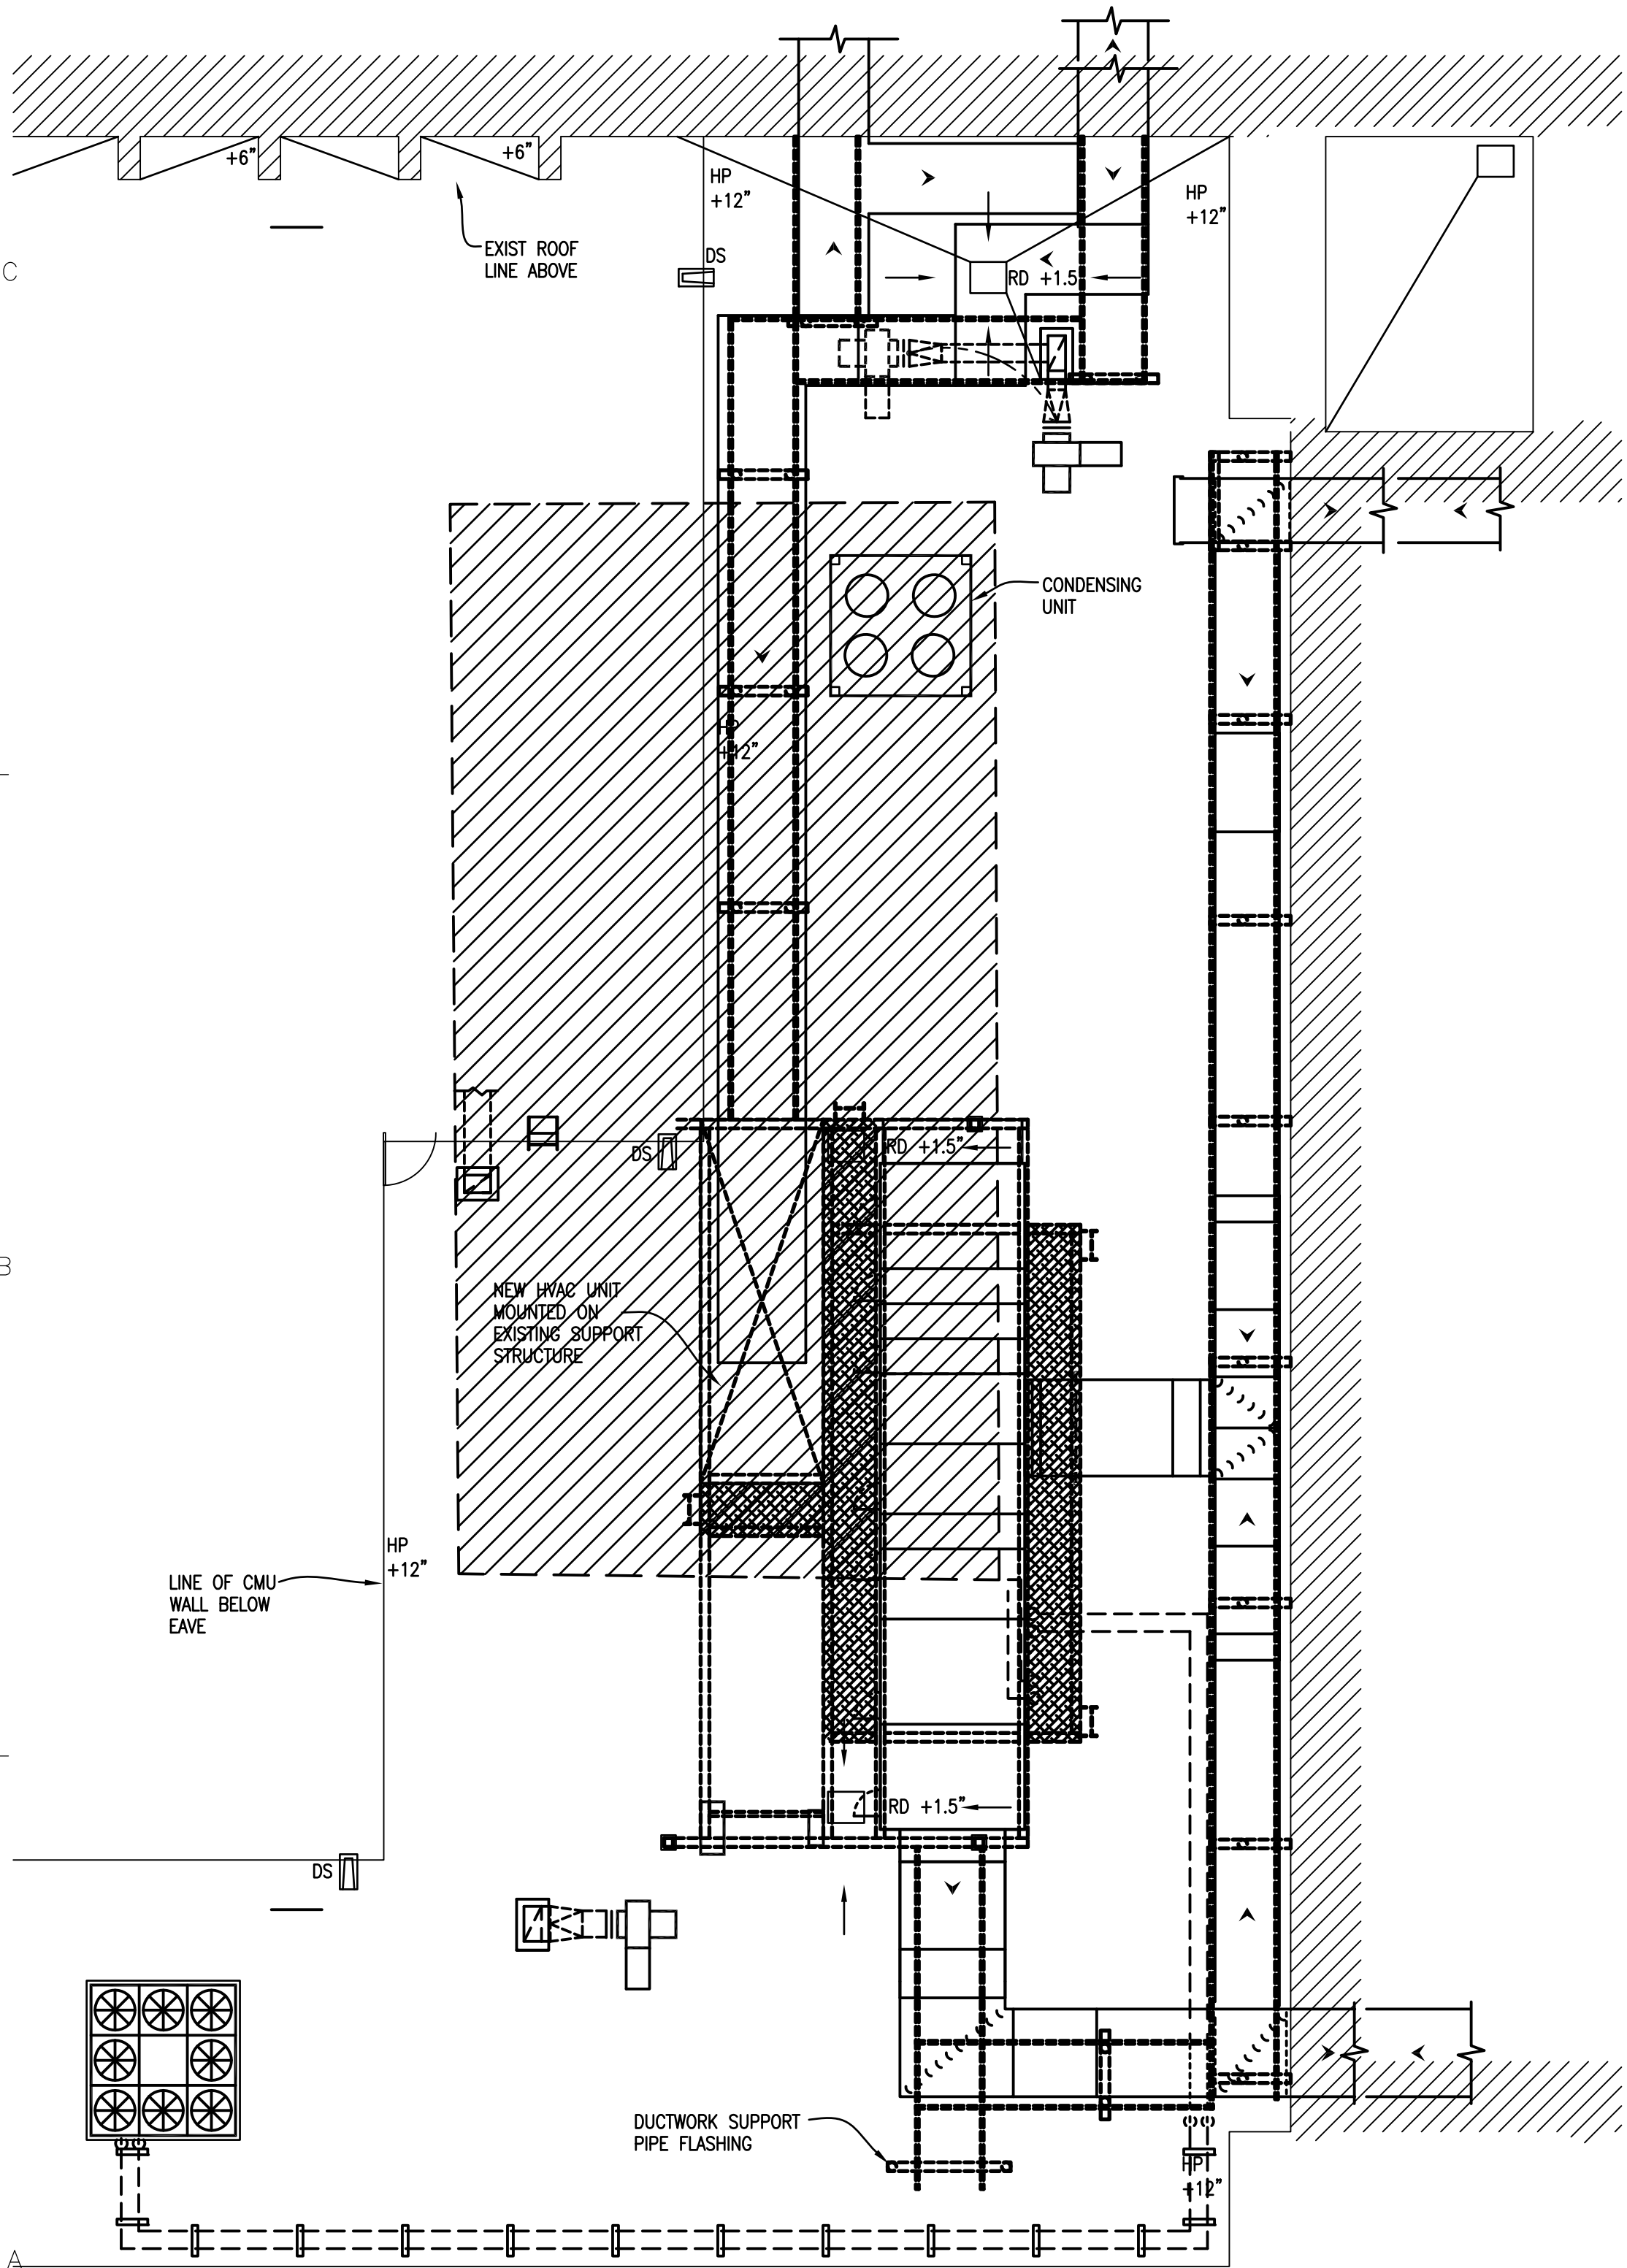

EXISTING ROOF PLAN - CORE AREA  
SCALE: 1/8" = 1'-0"

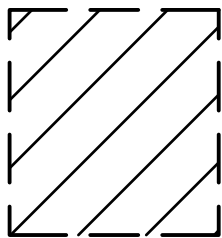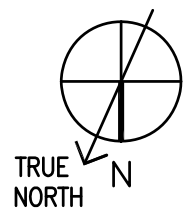

AREA OF  
CONSTRUCTION.

4' 0 4' 8'  
SCALE: 1/8"=1'-0"


EXISTING AIR HANDLING UNIT SCHEDULE																
UNIT NO.	SERVICE	LOCATION	CAPACITY		AIR FLOW CFM		TOTAL PRESS IN WG.	FAN MOTOR DATA					SEE OTHER SCHEDULES HC	MAKE AND MODEL	REMARKS	
			TOTAL COOLING LOAD MBH	HTG MBH	O.A. MIN	HIGH/LOW		HP	VOLTS	PHASE	HZ	FAN SPEED SF/RF				RPM
AH-15	POOL AREA	PENTHOUSE	568	704	2250	20500	1.75	25	460	3	60	831	--	--	POOL PAK SWHP 220	NOTE-1-2

EQUIP SUPPORT NOTE:

CONTRACTOR TO PROVIDE ANY MATERIALS NECESSARY TO ATTACH NEW EQUIPMENT TO EXISTING EQUIPMENT SUPPORT STRUCTURE TO ACCEPT NEW MECHANICAL EQUIPMENT.

NOTE:


1. THE REMOVAL AND REPLACEMENT OF ROOF TOP MECHANICAL EQUIPMENT WILL NEED TO BE PRE-SCHEDULED AND COORDINATED WITH THE CONTRACTING OFFICER'S REPRESENTATIVE. MINIMAL EQUIPMENT DOWN TIME WILL BE ALLOWED DURING REPLACEMENT

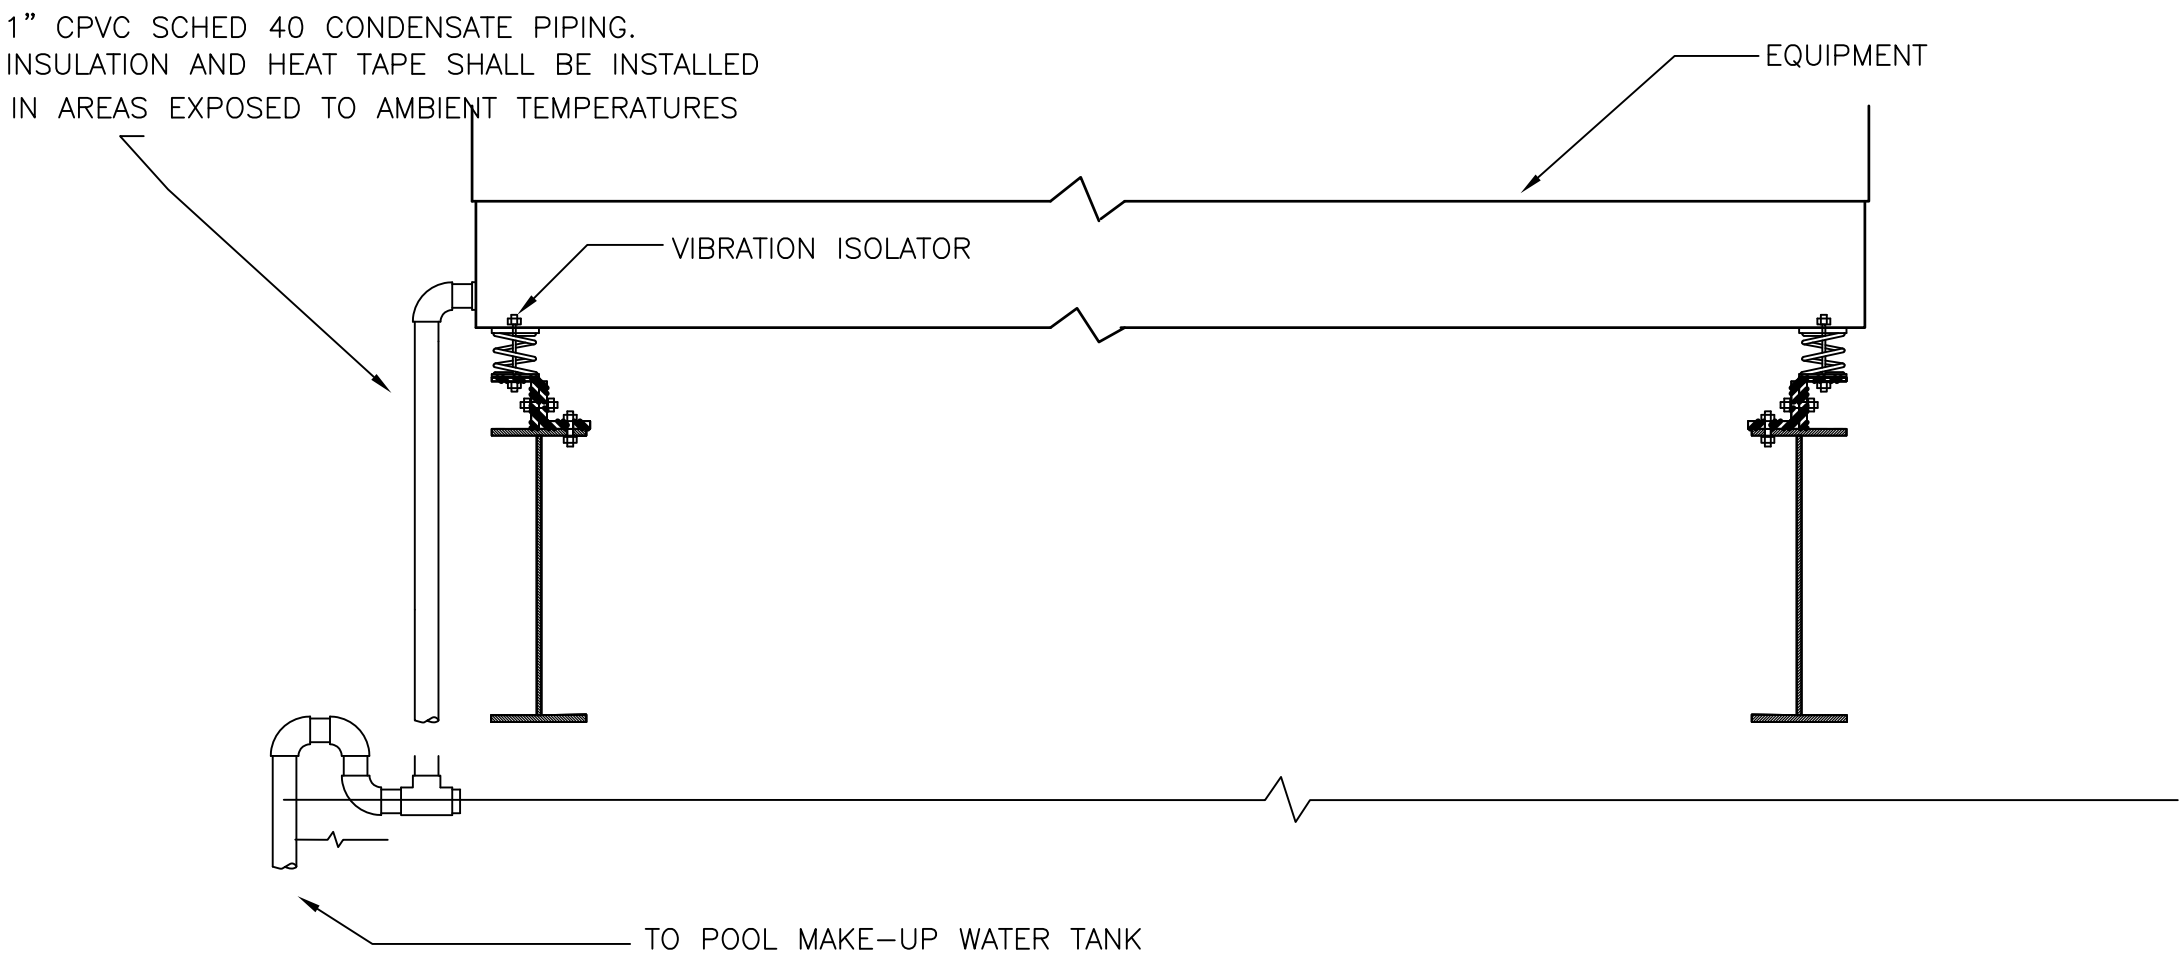

DETAIL 1 EXISTING ROOF UNIT BASE  
SCALE: N.T.S.

CONSULTANTS

U. S. COAST GUARD  
TRAINING CENTER  
CAPE MAY

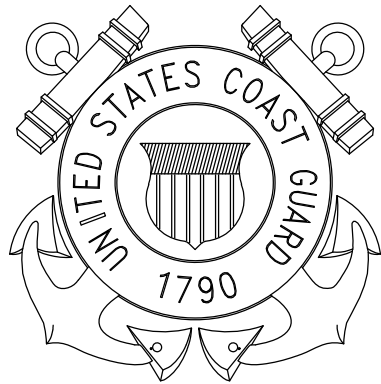

USCG TRACEN CAPE MAY  
1 MUNRO AVE.  
CAPE MAY, NJ 08204-5092

ISSUE		
MARK	DATE	DESCRIPTION

A/E PROJECT NO:  
CAD FILE NAME: T-7089-MD EXIST PLAN.dwg  
DESIGNED BY: LT JUSTIN DAVIS  
DRAWN BY: LT JUSTIN DAVIS  
EDITED BY:  
CHECKED BY:

SCALE: 1/8" = 1'-0" PLOT SCALE: 1 : 1

SHEET TITLE

GYM POOL VENTILATION UNIT REPLACEMENT  
TRACEN  
CAPE MAY NEW JERSEY  
GYM, RPFN 269  
MECHANICAL  
EXISTING ROOF PLAN - CORE AREA


PROJECT ENG.		BRANCH CHIEF	
APPROVING OFFICER		6/28/19 DATE	
PROJECT NUMBER		DRAWING NUMBER	
12672868		T-7089-MD	
DISCIPLINE/SHT NO		SHEET 3 OF 6	
M1			






AIR HANDLING UNIT SCHEDULE																					
UNIT NO.	SERVICE	LOCATION	CAPACITY		AIR FLOW CFM		TOTAL PRESS IN WG.	FAN MOTOR DATA					SEE OTHER SCHEDULES HC FILT.		MAKE AND MODEL	REMARKS	ELECTRICAL DATA DUAL POINT POWER				
			TOTAL COOLING LOAD MBH	HTG MBH	O.A. MIN	HIGH/LOW		HP	VOLTS	PHASE	HZ	FAN SPEED SF/RF					RPM	VOLTS	PHASE	HZ	COMPRESSOR CIRCUIT MCA/MOP
AH-15	POOL AREA	PENTHOUSE	566	689	2250	22500	1.75	25	460	3	60	831	--	--	POOLPAK PPK-220-PT-X-A4FH2203W2E5AD5	NOTE-1-2	460	3	60	89/100	78/90

NOTE:  
1. AIR COOLED CONDENSER POOL PAK MODEL NG-V-22-EUC-V. CAPACITY IS 700 MBH, 460V AND 3 PHASE. AIR COOLED CONDENSER REQUIRES TWO CIRCUITS, ONE FOR EACH COMPRESSOR.  
2. 25HP COMPRESSORS REQUIRED.

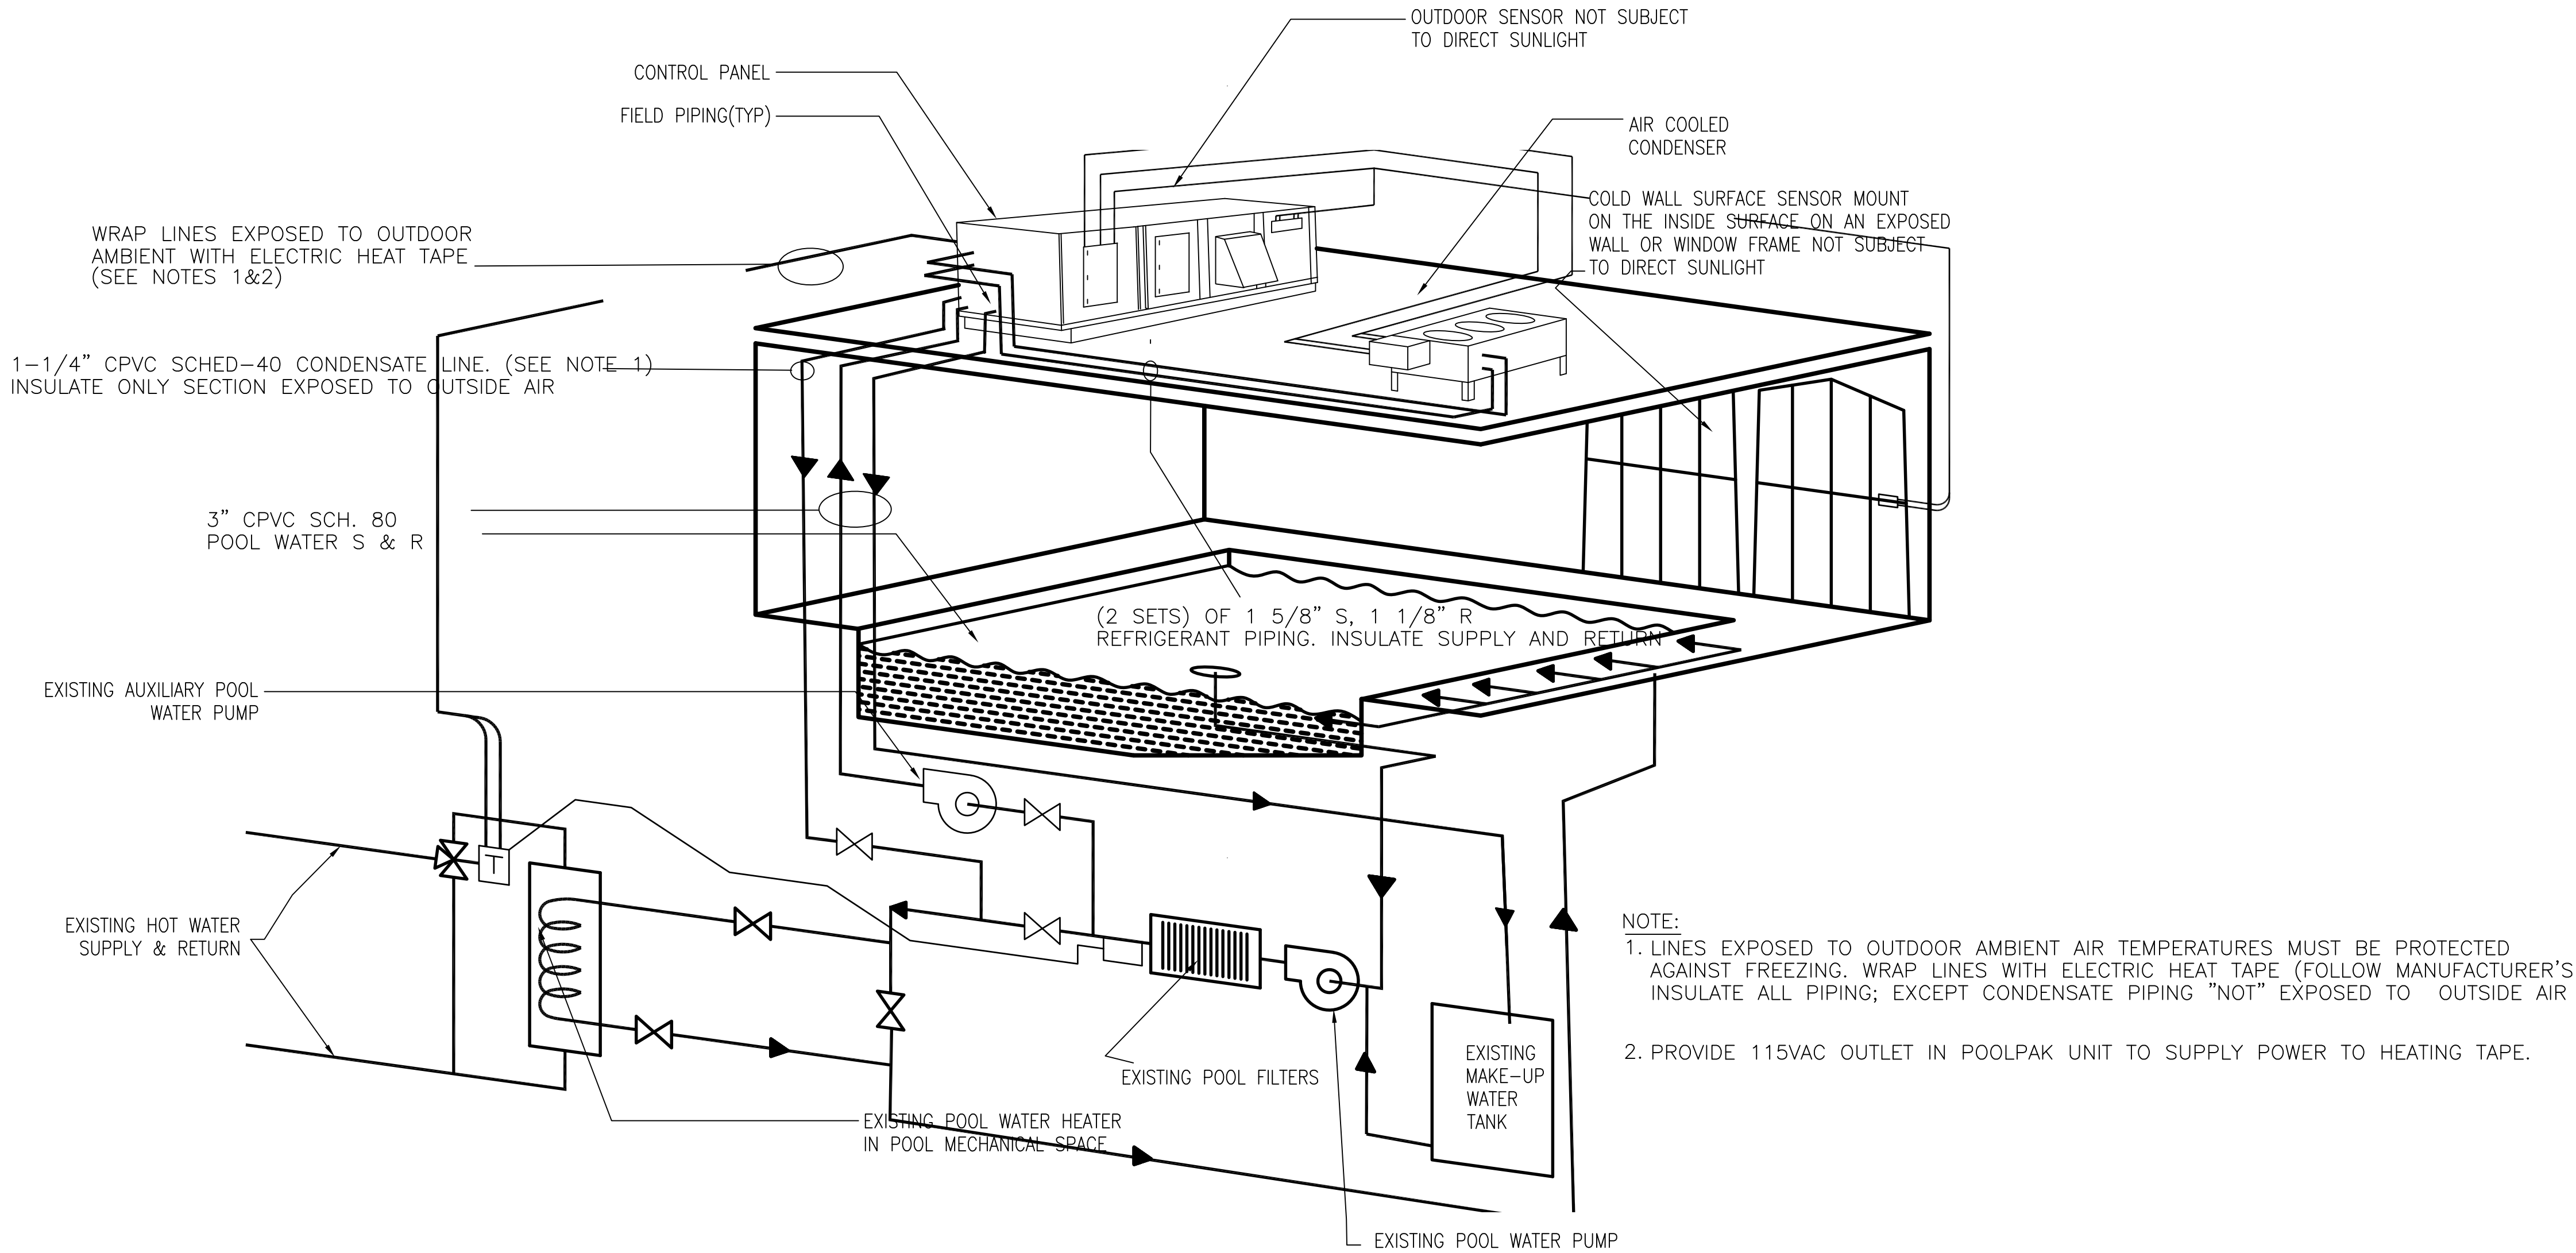


POOL HVAC SYSTEM WIRING & PIPING  
DIAGRAM  
SCALE: NTS

CONSULTANTS

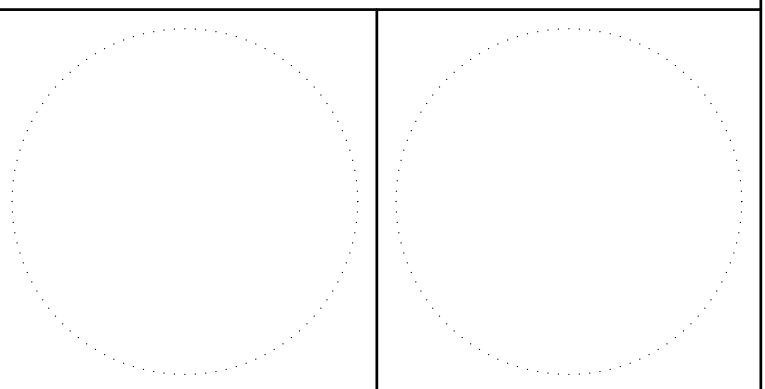

U. S. COAST GUARD  
TRAINING CENTER  
CAPE MAY

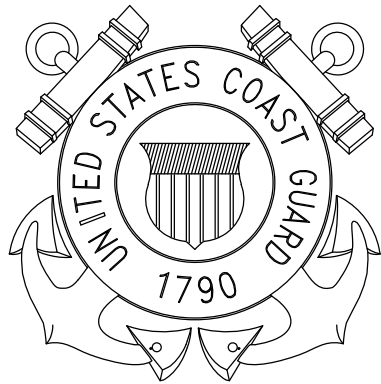

USCG TRACEN CAPE MAY  
1 MUNRO AVE.  
CAPE MAY, NJ 08204-5092

ISSUE		
MARK	DATE	DESCRIPTION


A/E PROJECT NO:	CMS-1576
CAD FILE NAME:	T-7091-MD HVAC DETAILS.dwg
DESIGNED BY:	LT JUSTIN DAVIS
DRAWN BY:	LT JUSTIN DAVIS
EDITED BY:	
CHECKED BY:	

SCALE: 1/8" = 1'-0" PLOT SCALE: 1 : 1

SHEET TITLE	
GYM POOL VENTILATION UNIT REPLACEMENT TRACEN CAPE MAY NEW JERSEY GYM, RPFN 269 MECHANICAL HVAC DETAILS AND SCHEDULE	

PROJECT ENG.		BRANCH CHIEF	
APPROVING OFFICER		6/28/19 DATE	
PROJECT NUMBER		DRAWING NUMBER	
12672868		T-7091-MD	
DISCIPLINE/SHT NO		SHEET 5 OF 6	
M3			



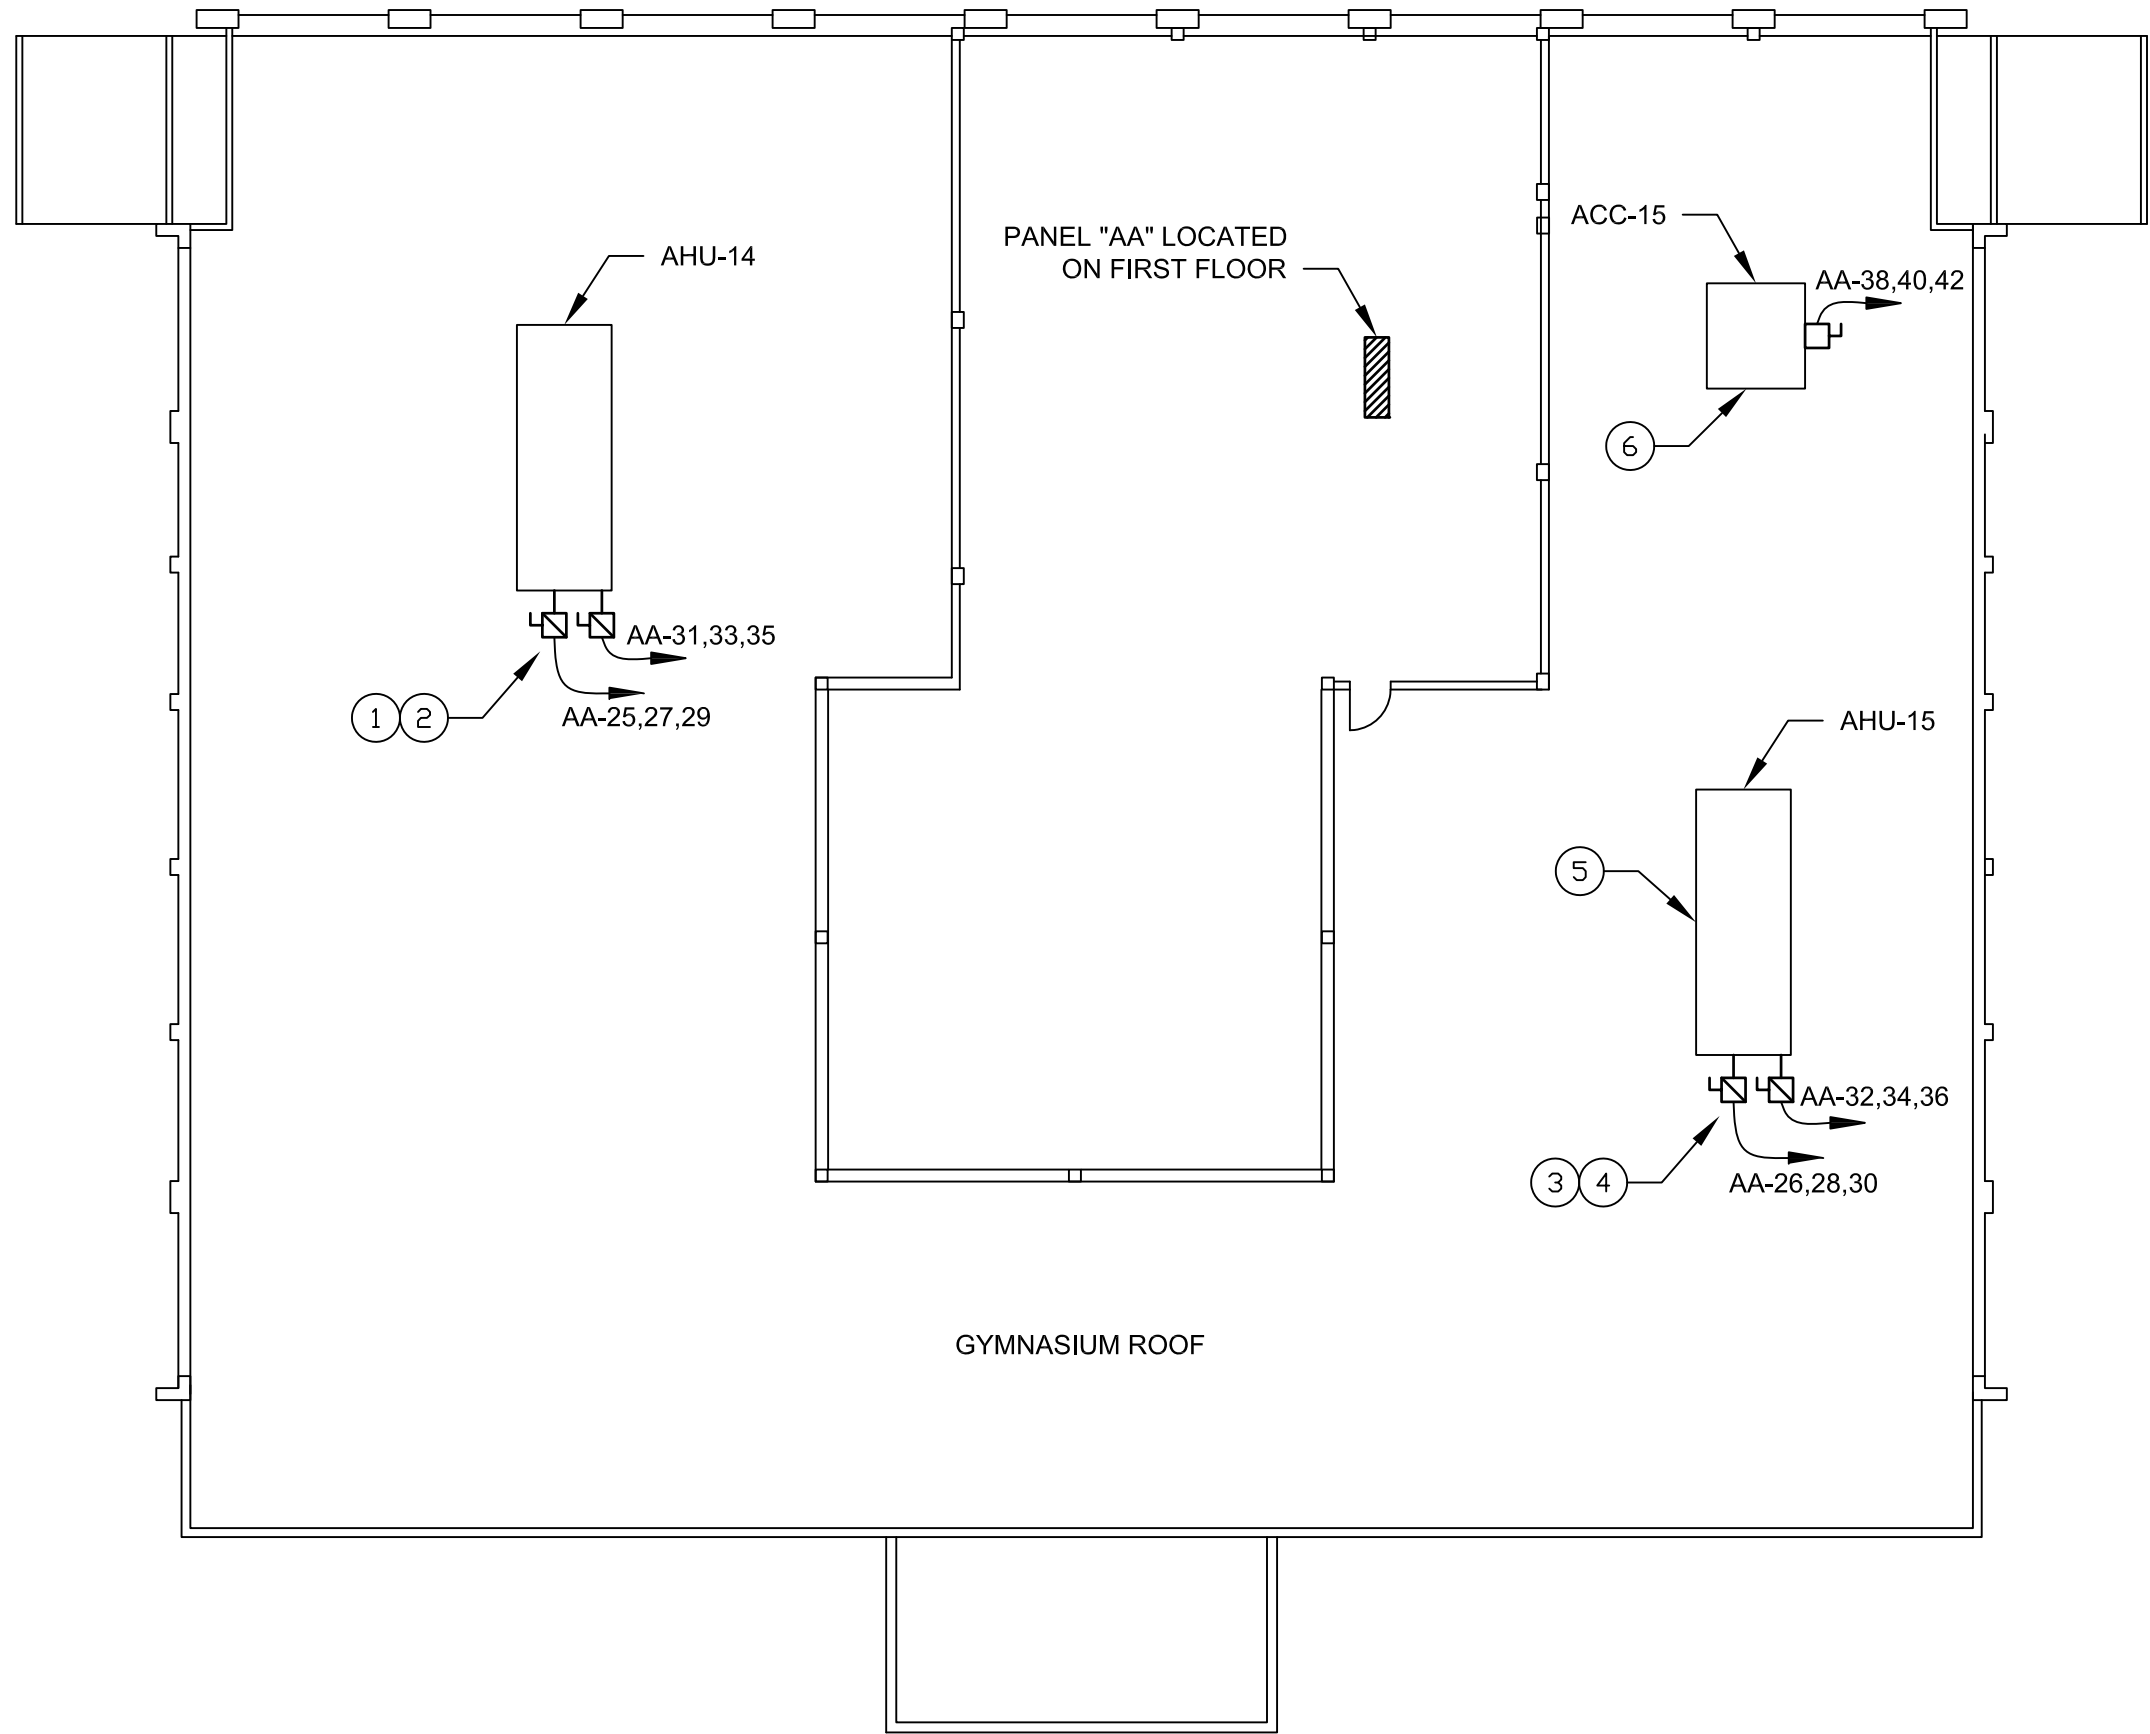

ELECTRIC,  
NEW WORK PLAN


SCALE: 1/16" = 1'-0"

CONSTRUCTION NOTES:

- DEMOLISH TWO NON-FUSED DISCONNECTS SERVING AHU-14. PROVIDE TWO NEW NEMA 3R, METAL, 3 POLE, FUSED DISCONNECTS. PROVIDE NEW DUAL ELEMENT, TIME DELAY, CURRENT LIMITING FUSES SIZED IN ACCORDANCE WITH THE ONE-LINE DRAWING.
- DEMOLISH WIRING BETWEEN PANEL "AA" AND AHU-14. PROVIDE NEW WIRING RUN IN EXISTING RIGID METAL CONDUIT.
- PROVIDE NEW CLASS RK5, DUAL ELEMENT, TIME DELAY, CURRENT LIMITING FUSES IN THE TWO EXISTING FUSED DISCONNECTS SERVING AHU-15. SIZE FUSES IN ACCORDANCE WITH THE MANUFACTURER'S RECOMMENDATION. SIZES SHOWN ARE BASED ON EXISTING HVAC EQUIPMENT. REFER TO GENERAL NOTE #1.
- DEMOLISH WIRING BETWEEN PANEL "AA" AND AHU-15. PROVIDE NEW WIRING RUN IN EXISTING RIGID METAL CONDUIT. IF NECESSARY, REPLACE / EXTEND RIGID METAL CONDUIT BETWEEN DISCONNECT AND NEW AHU-15.
- DISCONNECT / RECONNECT EXISTING FIRE ALARM CONTROL WIRING TO AHU-15.
- DISCONNECT / RECONNECT EXISTING NON-FUSED DISCONNECT SWITCH AND WIRING TO ACC-15. IF NECESSARY, REPLACE / EXTEND RIGID METAL CONDUIT AND WIRE BETWEEN DISCONNECT AND NEW ACC-15.


GENERAL NOTES:

- FUSE AND WIRE SIZES GIVEN FOR AHU-15 ARE COORDINATED WITH THE BASIS OF DESIGN HVAC EQUIPMENT. IF THE ACTUAL INSTALLED HVAC EQUIPMENT DIFFERS FROM THE BASIS OF DESIGN EQUIPMENT, THE CONTRACTOR SHALL INSTALL THE CORRECT SIZE CIRCUIT BREAKERS, FUSES, AND WIRE AS NECESSARY TO MEET THE LATEST NEC REQUIREMENTS AT NO ADDITIONAL COST TO THE GOVERNMENT. COORDINATE FINAL POWER REQUIREMENTS WITH MECHANICAL CONTRACTOR.
- ELECTRICAL WORK SHALL BE COMPLETED SUCH THAT EITHER AHU-14 OR AHU-15 IS OPERATIONAL AT ANY ONE TIME.
- COORDINATE ALL POWER OUTAGES WITH THE CONTRACTING OFFICER'S REPRESENTATIVE.

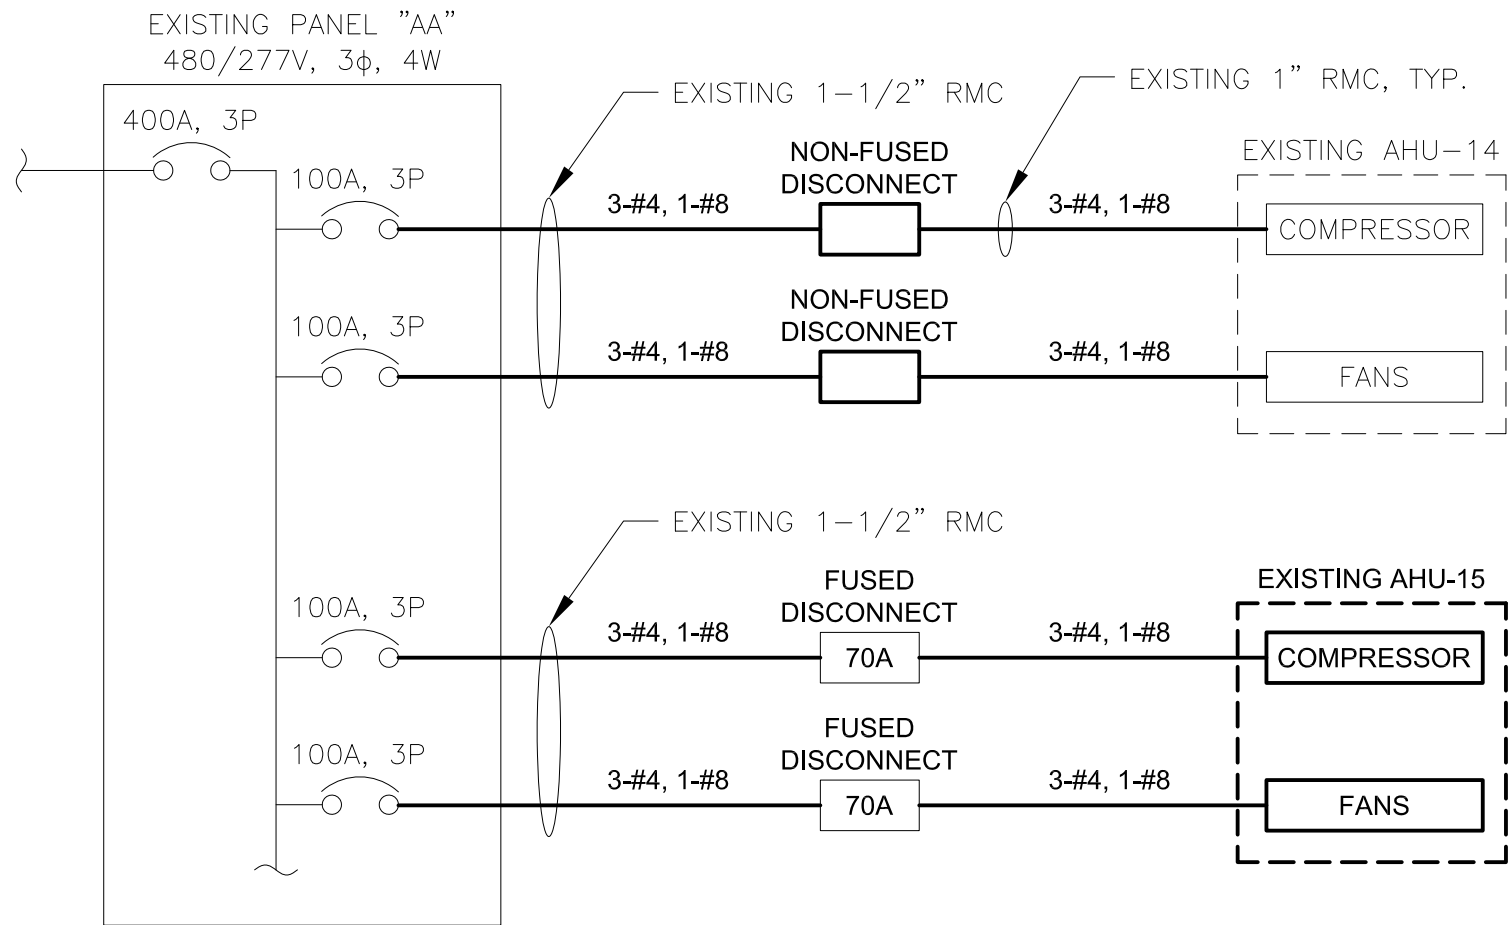

EXISTING ONE-LINE

SCALE: NONE

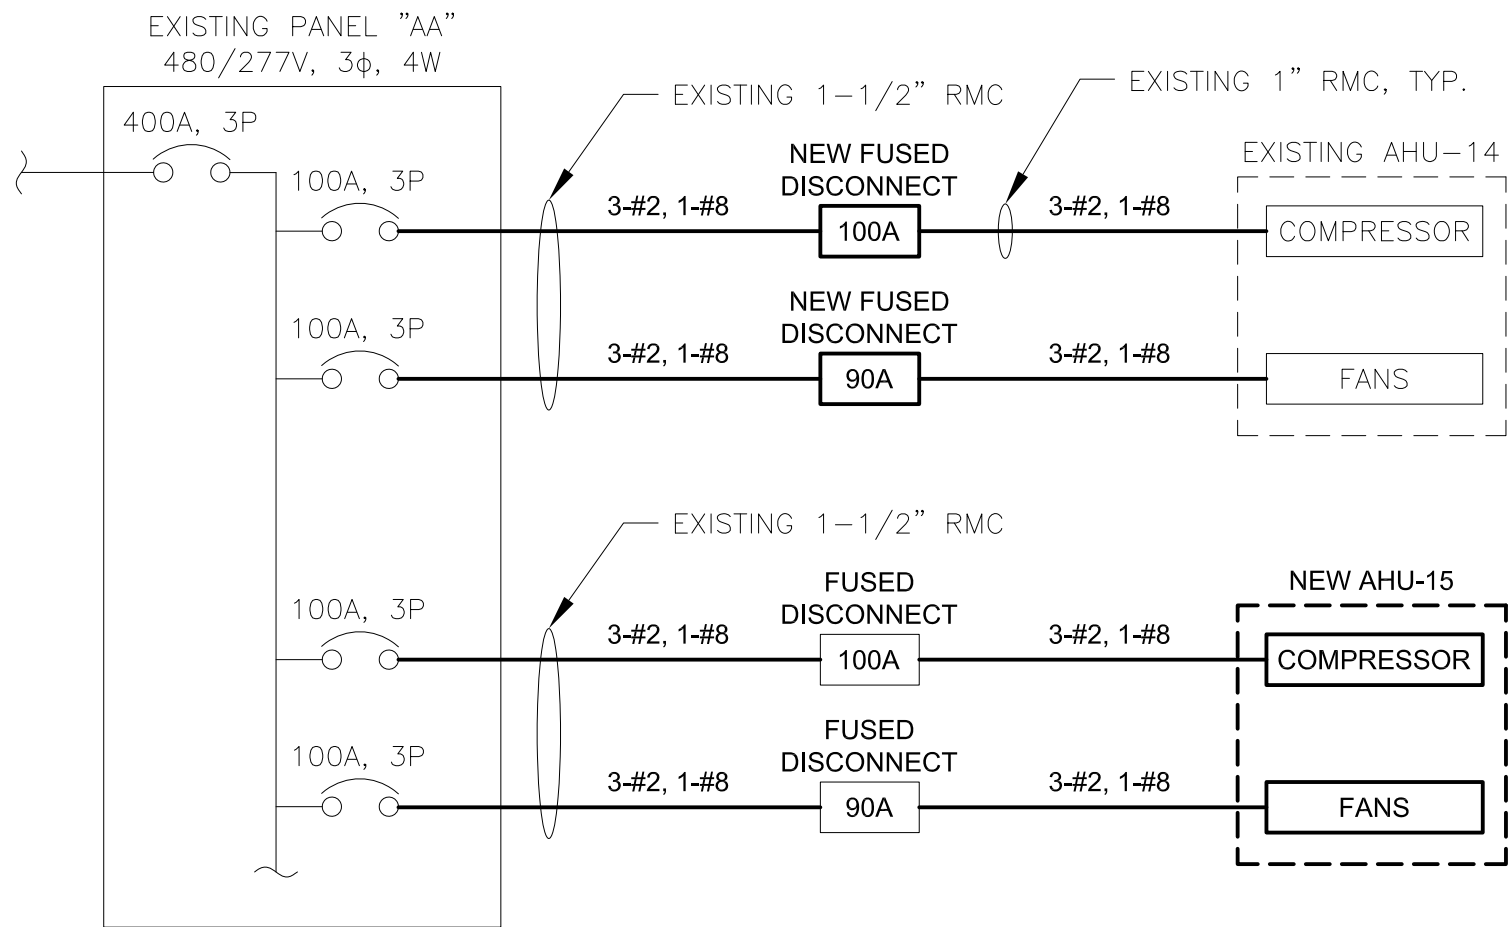

NEW ONE-LINE

SCALE: NONE

LEGEND


- AA-1,3,5 HOMERUN, PANEL AND CIRCUIT # INDICATED
- DISCONNECT SWITCH, NON-FUSED
- DISCONNECT SWITCH, FUSED
- ACC AIR COOLED CONDENSER
- AHU AIR HANDLING UNIT
- RMC RIGID METAL CONDUIT

GRAPHICAL SCALE: 1/16" = 1'



CONSULTANTS

U. S. COAST GUARD  
TRAINING CENTER  
CAPE MAY

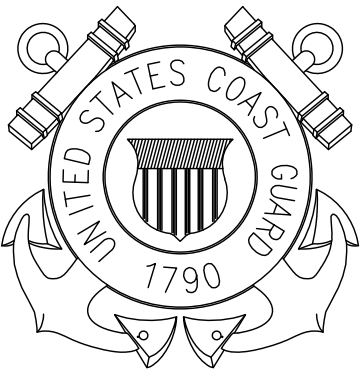

USCG, TRACEN CAPE MAY  
1 MUNRO AVE.  
CAPE MAY, NJ 08204-5092

ISSUE

MARK	DATE	DESCRIPTION

A/E PROJECT NO: CMS-1576

CAD FILE NAME:

DESIGNED BY: SCM

DRAWN BY: SCM

EDITED BY:

CHECKED BY:

SCALE: AS SHOWN PLOT SCALE:

SHEET TITLE

POOL VENTILATION UNIT REPLACEMENT  
TRACEN  
CAPE MAY, NEW JERSEY  
GYM, BUILDING #269  
ELECTRICAL  
DEMO & NEW WORK PLANS

PROJECT ENG.

BRANCH CHIEF

APPROVING OFFICER

6/28/19  
DATE

PROJECT NUMBER

12672868

DISCIPLINE/SHT NO

E/1

DRAWING NUMBER

T-7091A-ED

SHEET 6 OF 6